


Title: JM 1050 IGC Installation Into Masonry Surround		Drawing No: M04	
Scale: 1:10	Drawn: W J Gardzow & Associates	The Fireplace Ltd	
Revision: C	Date: 03-06-2008	Phone: (09) 623 6990	
		Fax: (09) 623 6994	
		12 Tawnt Street - Mt. Eden - Auckland - New Zealand	
		www.thefireplace.co.nz email: sales@thefireplace.co.nz	

NOTE: For Air vent requirements please refer to NZS 5261


Place Rock-wool to the rear, sides and top of the Gas Jetmaster (Glue rock-wool using fire cement or mechanical fix using pot rivets with washer to the convetor box and gather)

Hebel Block


NOTE: DO NOT BLOCK OFF AIR FLOW TO FLUE-PIPE CASING

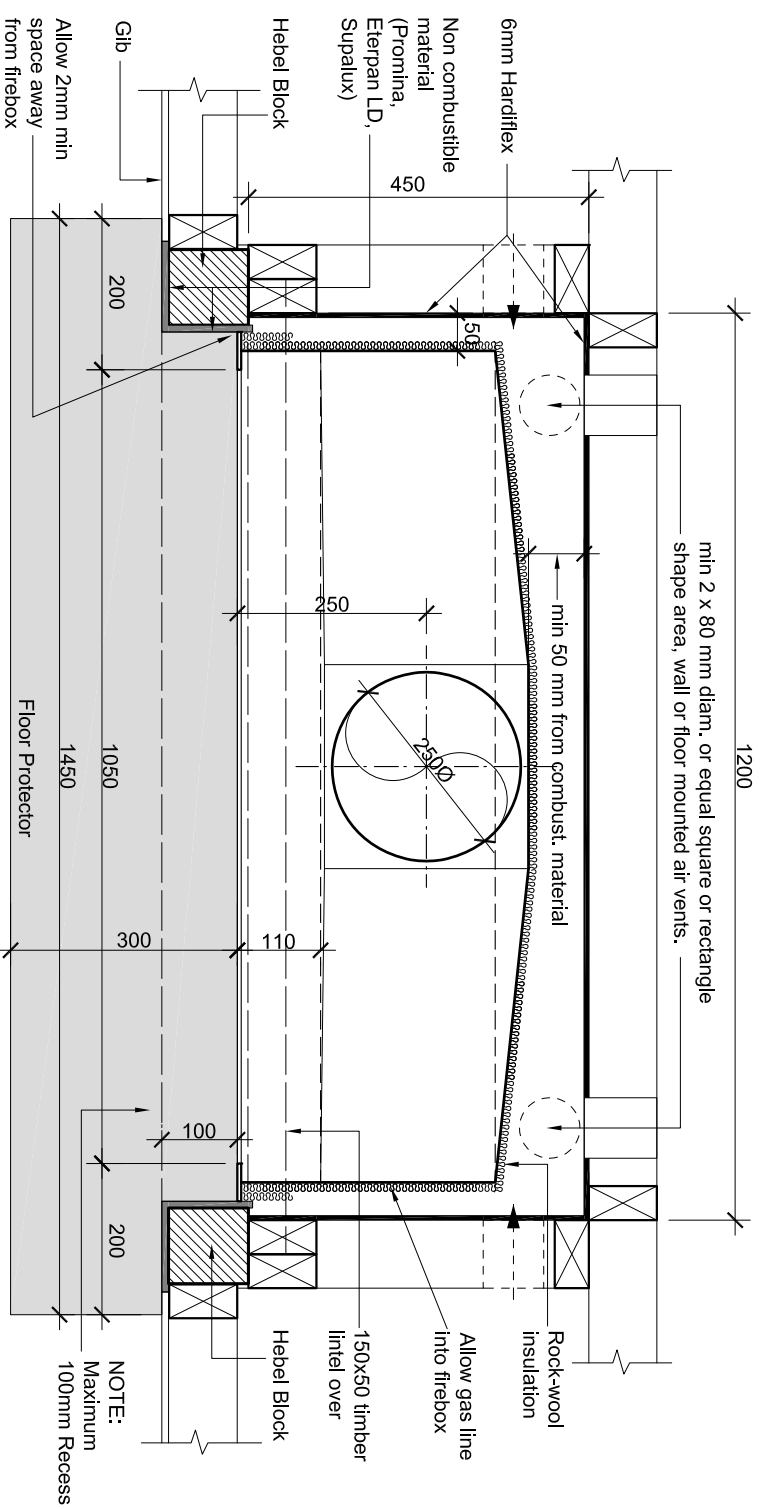


RECESSED PLAN VIEW

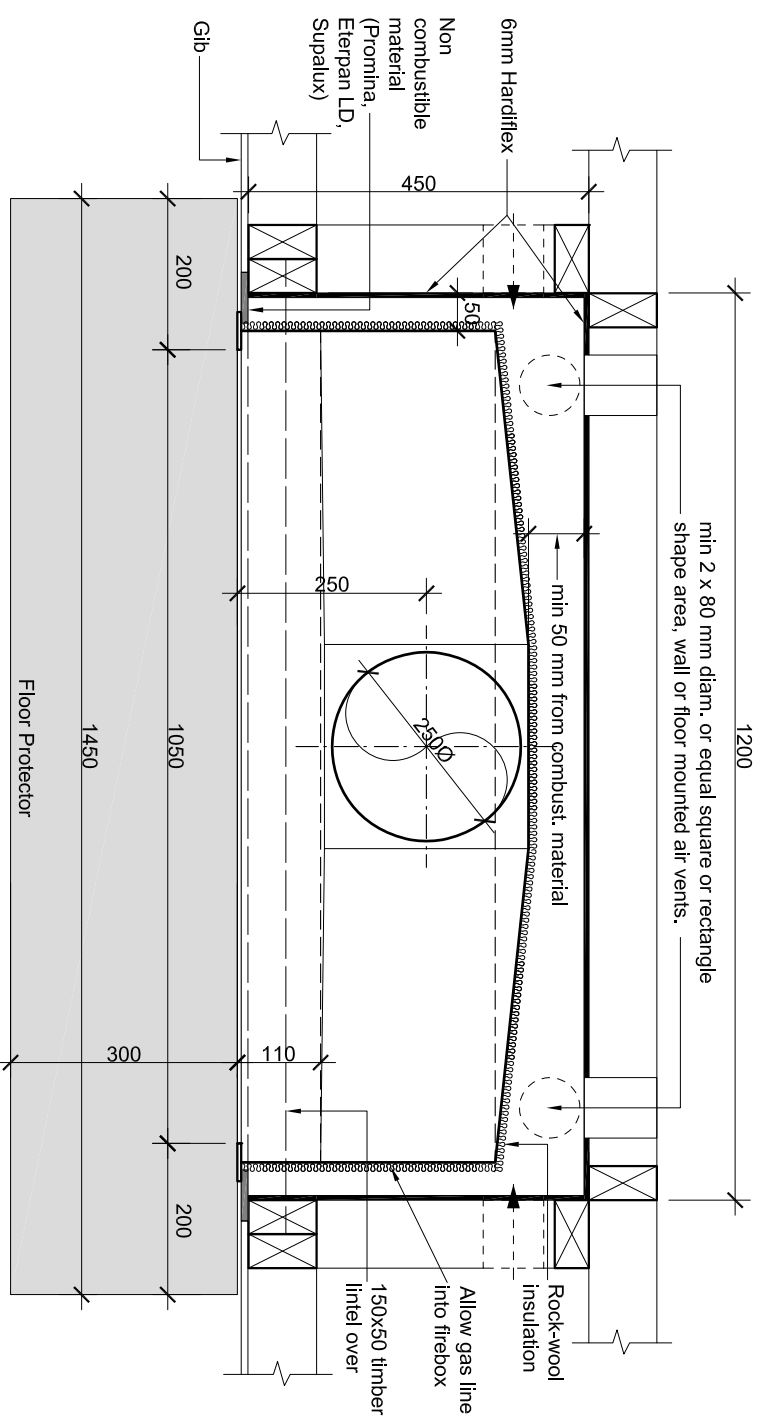

PLAN VIEW

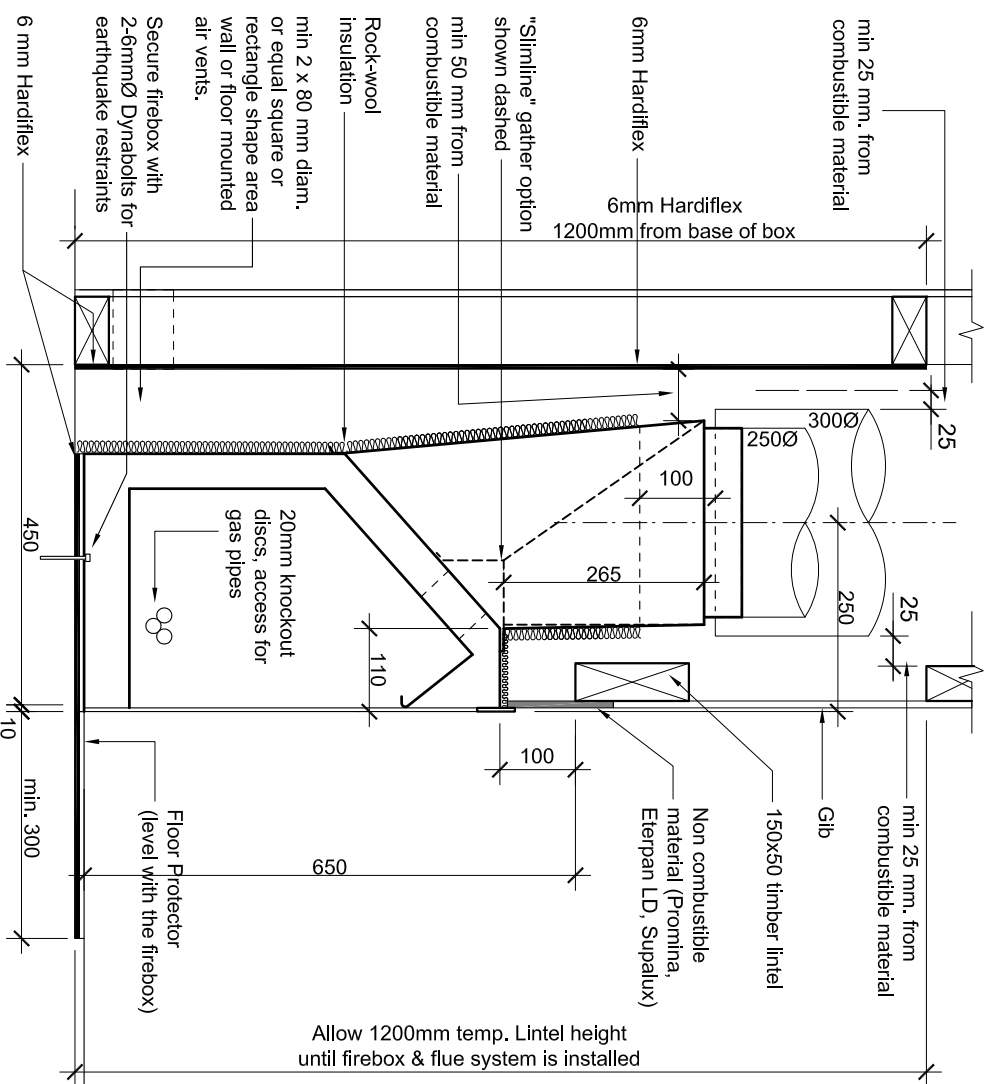

CROSS SECTION




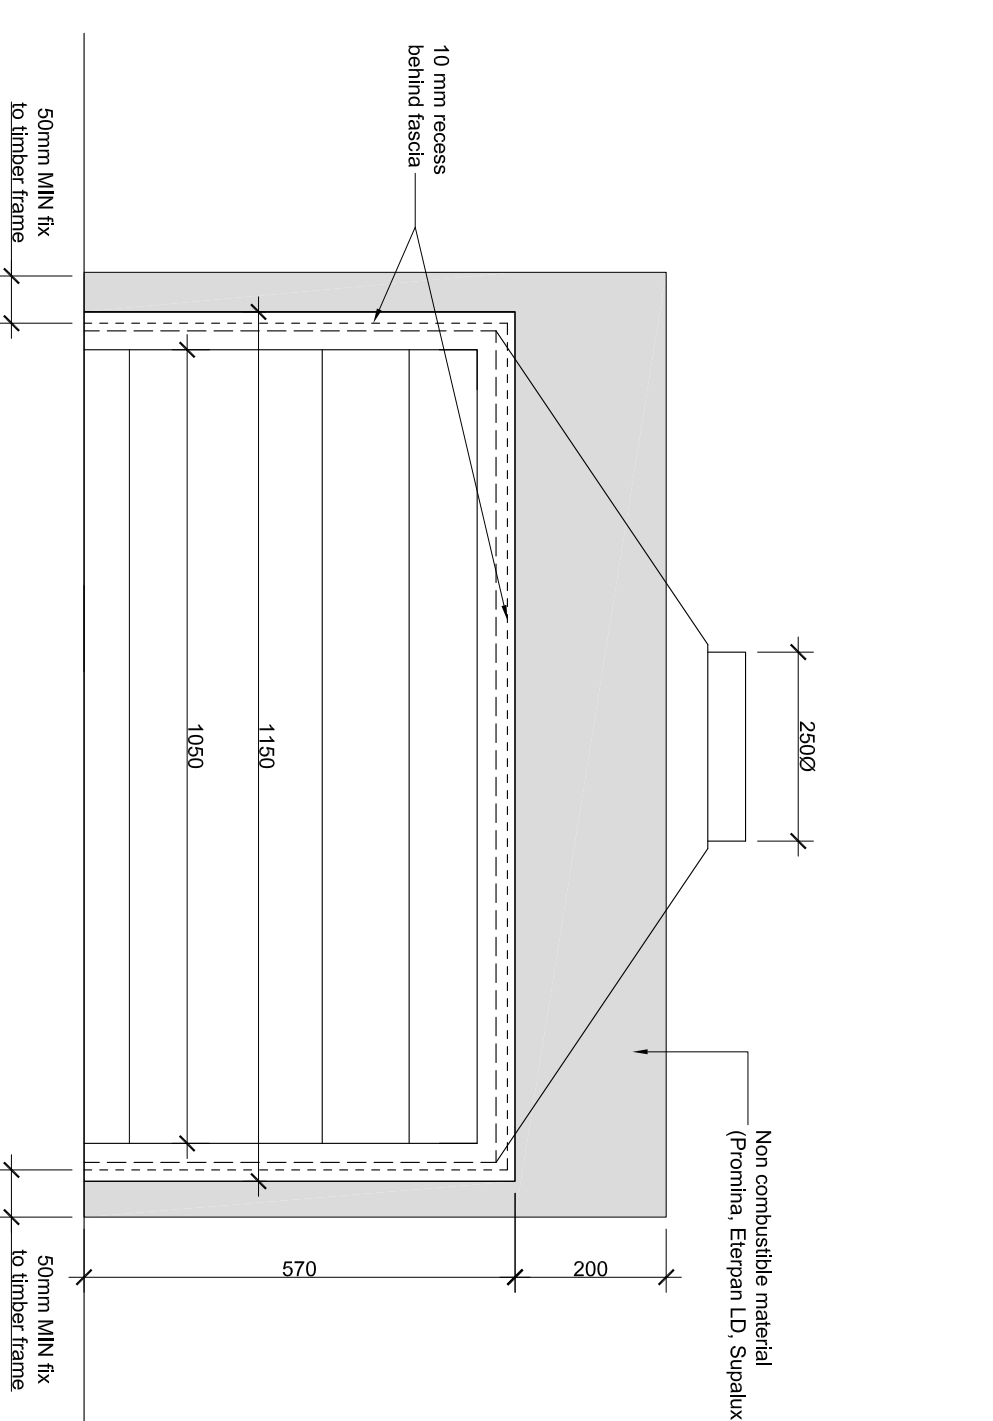


FRONT ELEVATION


Title: JM 1050 IGC Installation Into Timber Framing	Drawing No: T04	The Fireplace Ltd
Scale: 1:10	Drawn: W. J. Cadzow & Associates	Phone: (09) 623 6990
Revision: A	Date: 03-06-2008	Fax: (09) 623 6994
		12 Tawai Street - Mt. Eden - Auckland - New Zealand
		www.thefireplace.co.nz email: sales@thefireplace.co.nz

NOTE: For Air vent requirements please refer to NZS 5261

Please Rock-wool to the rear, sides and top of the Gas Jernister (Glue Rock-wool using the Cement or mechanical fix using pot rivets with washer to the convactor box and gather) NOTE: DO NOT BLOCK OFF AIR FLOW TO FLUE-PIPE CASING

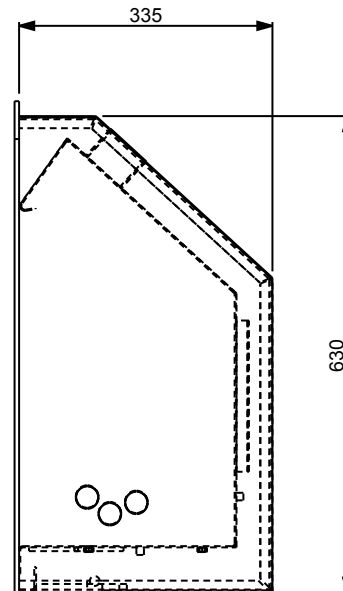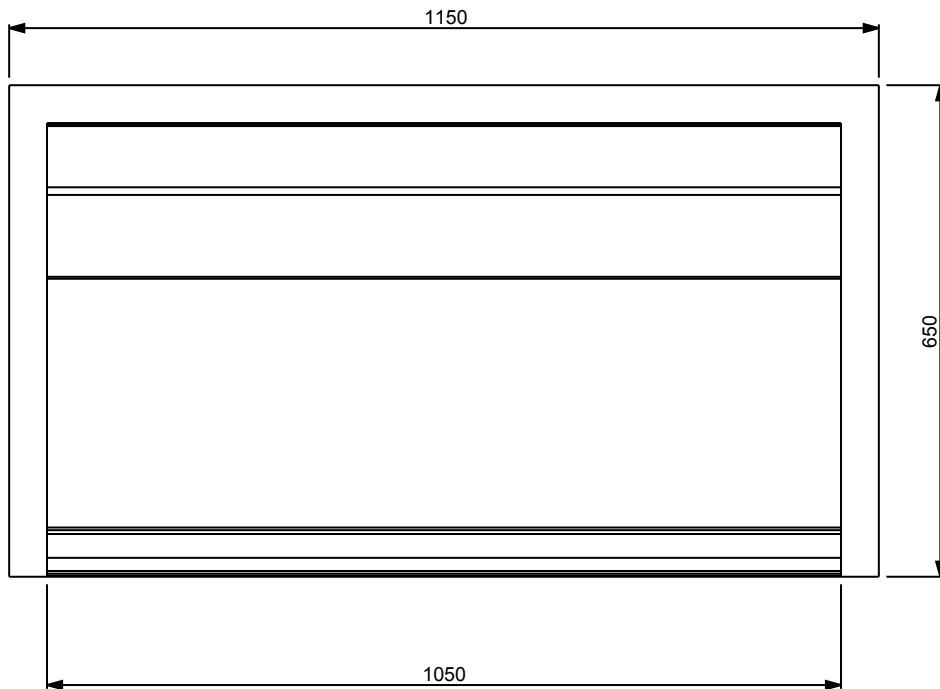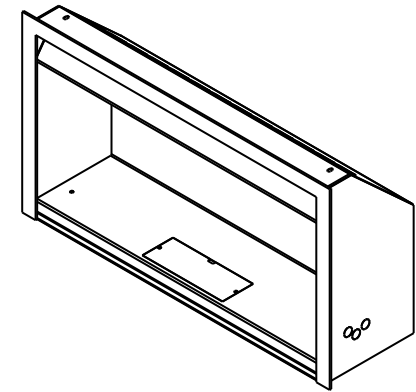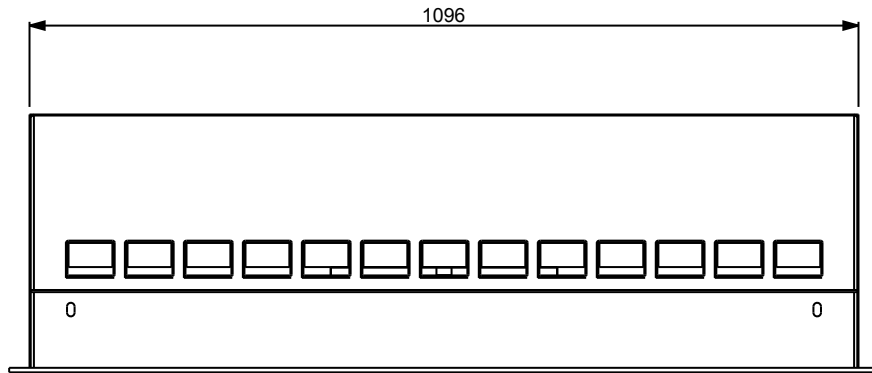

SCALE 1:10

REFERENCE DIMENSION SHEET 			
PRODUCT DESCRIPTION		IGC 1050 FULL ASSEMBLY 1050 IGC	
DRAWING NUMBER		REFERENCE_1050_IGC	
DRAWING REVISION			
DATE	19-Nov-09	SHEET	1 OF 1
THIS IS A REPRESENTATION OF THE PRODUCT REFERENCED ABOVE. NOT TO BE USED AS MANUFACTURING REFERENCE			